

BUILDING CODES:
 2003 IRC
 2002 NEC


IECC 2003
 TENN. PUBLIC BUILDINGS ACCESSIBILITY ACT
 SAFETY GLAZING MATERIALS
 OCCUPANCY:
 RESIDENTIAL - R3
 CONSTRUCTION TYPE:
 VB - UNPROTECTED
 INSULATION:
 ROOF R-30 OR R-38
 WALL R-13 OR R-14
 FLOOR R-19 OR R-14
 FURNACE REQUIRED - 12 KW.
 BUILDING IS UNSPRINKLERED

DESIGN LOADS:
 LIVE ROOF LOAD - 30 PSF
 DEAD ROOF LOAD - 15 PSF
 WIND LOAD - 90 MPH
 90 MPH: EXPOSURE "C"
 SEISMIC DESIGN: C
 LIVE FLOOR LOAD - 40 PSF
 DEAD FLOOR LOAD - 10 PSF
 NUMBER OF FLOORS: 1
 FLOOR AREA: 1,334 SQ. FT.

TENNESSEE MODEL 746

1,334 SQUARE FEET
 ACTUAL SIZE - 30'4" X 44'0"
 TRANSPORTATION SIZE - 32 X 48
 ▲ LABEL LOCATION

- LEGEND
- L-101 - LITERATURE PLAN
 - AP-101 - FLOOR PLAN
 - EP-101 - ELECTRICAL PLAN
 - EV-101 - ELEVATIONS
 - A-103 - TYPICAL CROSS SECTION OFF-FRAME
 - A-104 - TYPICAL CROSS SECTION ON-FRAME
 - K-101 - CABINET LAYOUT
 - P-101 - DRAIN LINE PLAN
 - W-101 - WATER SCHEMATIC
 - F-101 - BLOCCING FOUNDATION
 - F-201 - BLOCKING FOUNDATION DETAILS-90 MPH WIND (TYP)
 - F-202 - TYPICAL OFF-FRAME FOUNDATION-90 MPH WIND (TYP)
 - F-301 - PERIMETER FOUNDATION
 - F-401 - FOUNDATION PLAN - 90 MPH WIND (TYP)
 - G-101 - TYPICAL GAS RISER DIAGRAM

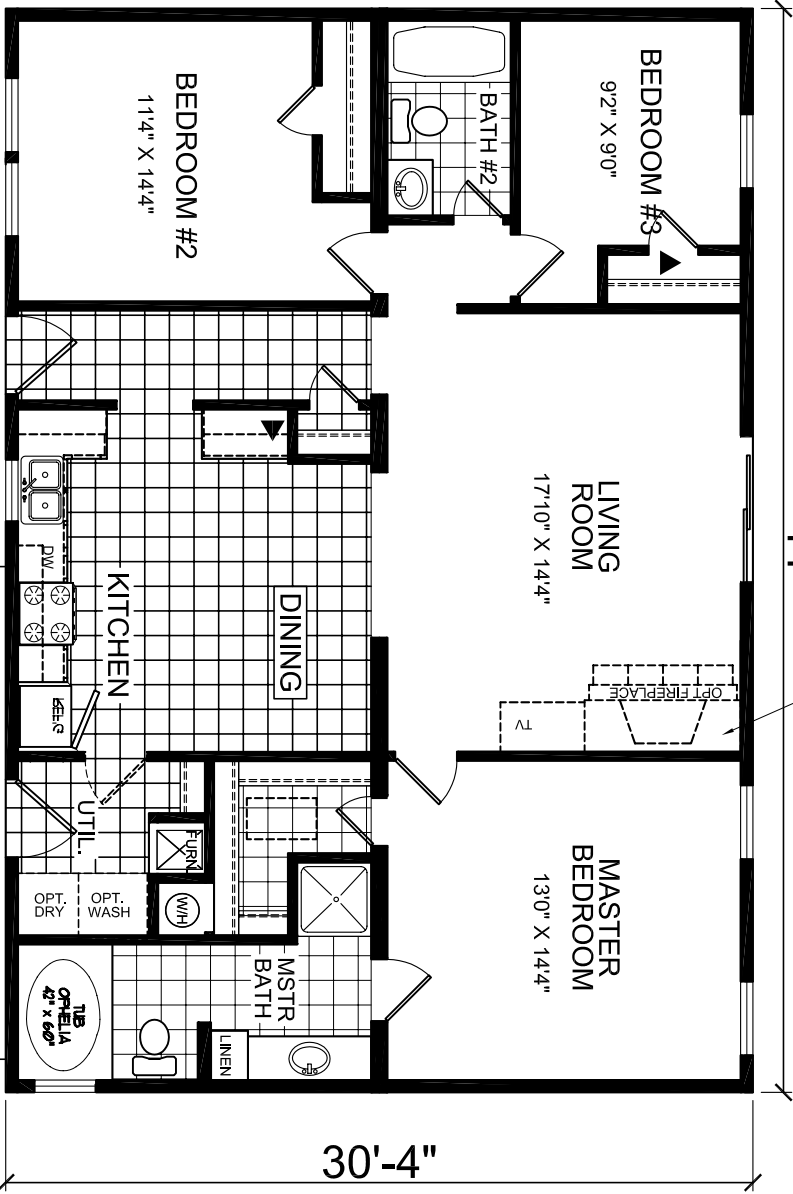

OPTIONAL
 CORNER B
 FIREPLACE

GARAGE BY OTHERS

MODIFICATIONS



MODEL: 21-746	32X48-3BDRM
TITLE: LITERATURE PLAN	
DRAWN BY: DIV-21	DATE: 05-01-03
SCALE: 1/8" = 1'-0"	

SHEET: L-101

